1. THIS SHEET CONTAINS SYMBOLS AND ABBREVIATIONS TYPICALLY SHOWN ON ELECTRICAL DRAWINGS AND SCHEMATICS. THIS CONTRACT drawing set may not contain all symbols and abbreviations shown on this sheet.

- THE CONTRACTOR SHALL OBTAIN ALL REQUIRED PERMITS AND ARRANGE FOR ALL REQUIRED INSPECTIONS IN ACCORDANCE WITH STATE AND LOCAL GOVERNING AUTHORITIES.
- 2. ALL WORK SHALL BE DONE IN ACCORDANCE WITH THE 2020 NEC, AND STATE AND LOCAL GOVERNING REGULATIONS. 3. PERFORM WORK AS REQUIRED BY CODES, REGULATIONS, LAWS OF LOCAL, STATE AND FEDERAL GOVERNMENTS, AND OTHER AUTHORITIES WITH LAWFUL JURISDICTION. ALL MATERIAL AND EQUIPMENT SHALL BE UL, NEMA, ANSI, IEEE, ADA & CBM

# SCOPE 1. UNLESS OTHERWISE INDICATED, PROVIDE A COMPLETE AND OPERATIONAL ELECTRICAL SYSTEM INCLUDING ALL NECESSARY MATERIAL,

- LABOR, AND EQUIPMENT. 2. ALL DISCONNECTS REQUIRED BY CODE MAY NOT BE SHOWN, CONTRACTOR SHALL PROVIDE ALL NECESSARY DISCONNECTS AND OVERCURRENT PROTECTIVE DEVICES.
- 3. ALL EQUIPMENT AND MATERIAL SHALL BE LABELED AND LISTED, AND INSTALLED IN ACCORDANCE WITH THEIR LISTING. 4. PROVIDE ELECTRICAL CONNECTION FOR EVERY FIXTURE, OR ITEM OF EQUIPMENT REQUIRING SAME, WHICH IS SHOWN OR LISTED ON ANY
- 5. CONTRACTOR SHALL PROVIDE NECESSARY SUPPORT FRAMING, STIFFENERS, BRACING, AND HANGERS WHETHER SHOWN OR NOT TO ENSURE A COMPLETE AND DURABLE SYSTEM. SUPPORT FRAMING CONNECTIONS SHALL BE WELDED UNLESS SPECIFICALLY SHOWN OTHERWISE. ACTUAL SUPPORTS MAY VARY FROM THOSE SHOWN IN DETAILS TO ACCOMMODATE EXISTING FIELD CONDITIONS.
- 6. THE WORK INCLUDED IN THIS CONTRACT ENCOMPASSES THE DRAWINGS AND SPECIFICATIONS. WORK INCLUDED ON THE DRAWINGS ONLY, OR IN THE SPECIFICATIONS ONLY, SHALL BE INCORPORATED AS IF INCLUDED IN BOTH. ALL SYSTEMS SHOWN ARE INTENDED TO BE COMPLETE AND FULLY FUNCTIONING. THE CONTRACTOR SHALL PROVIDE SUCH COMPONENTS AS NECESSARY FOR A FULLY FUNCTIONING
- 7. ALL EQUIPMENT SHALL BE INSTALLED IN A NEAT AND WORKMANLIKE MANNER, RECTILINEAR TO BUILDING STRUCTURE. 8. CONTRACTOR SHALL FIELD VERIFY ALL SITE CONDITIONS AND DIMENSIONS PRIOR TO COMMENCEMENT OF ANY WORK OR SHOP FABRICATION. REQUIRED CHANGES TO WORK SHOWN ON CONSTRUCTION DRAWINGS SHALL BE APPROVED BY THE ENGINEER IN WRITING, OTHER TRADES, AND OWNER AS REQUIRED PRIOR TO ANY CONSTRUCTION.

THE CONTRACTOR SHALL COORDINATE AND VERIFY THAT WORKING AND DEDICATED EQUIPMENT SPACE REQUIREMENTS ARE MET PER NEC

- 2. FIELD LOCATE ALL CORE DRILL LOCATIONS.
- 3. BEFORE CUTTING OR DRILLING INTO BUILDING ELEMENTS INSPECT AND LAYOUT WORK TO AVOID DAMAGING STRUCTURAL ELEMENTS AND BUILDING UTILITIES. 4. BEFORE SELECTING MATERIAL/EQUIPMENT AND PROCEEDING WITH WORK, INSPECT AREAS WHERE MATERIAL AND EQUIPMENT ARE TO BE
- INSTALLED TO INSURE SUITABILITY, AND CHECK NEEDED SPACE FOR PLACEMENT, CLEARANCES AND INTERCONNECTIONS. 5. POSSIBLE SYSTEM SHUT-DOWNS AND WORK AREAS CLOSURES MUST BE COORDINATED WITH THE OWNER.
- 6. TURN OVER TO THE OWNER ALL MANUFACTURER'S WARRANTIES FOR EQUIPMENT AND MATERIALS PROVIDED.

- DEFINITIONS

  1. THE DEFINITION OF ELECTRICAL TERMS USED SHALL BE AS DEFINED IN THE EDITION OF THE NATIONAL ELECTRIC CODE (NEC) AS REFERENCED
- 2. THE TERM "INDICATED" SHALL MEAN "AS SHOWN ON CONTRACT DOCUMENTS (SPECIFICATIONS, DRAWINGS, AND RELATED ATTACHMENTS)". 3. THE TERM "PROVIDE" SHALL MEAN "TO FURNISH, INSTALL, AND CONNECT COMPLETELY".
- 4. THE TERM "SIZE" SHALL MEAN ONE OR MORE OF THE FOLLOWING: "LENGTH, CURRENT AND VOLTAGE RATING, NUMBER OF POLES, NEMA SIZE, AND OTHER SIMILAR ELECTRICAL CHARACTERISTICS".

- PLANS

  1. ELECTRICAL PLANS, DETAILS, AND ONE LINE DIAGRAMS SHOW THE GENERAL LOCATION AND ARRANGEMENT OF THE ELECTRICAL SYSTEM. THEY ARE DIAGRAMMATIC AND DO NOT SHOW ALL CONDUIT BODIES, CONNECTORS, BENDS, FITTINGS, HANGERS, AND ADDITIONAL PULL BOXES WHICH THE CONTRACTOR MUST PROVIDE TO COMPLETE THE ELECTRICAL SYSTEM.
- 2. ELECTRICAL PLANS AND DETAILS DO NOT SHOW ALL INTERFERENCES AND CONDITIONS, VISIBLE AND/OR HIDDEN, THAT MAY EXIST.
- CONTRACTOR MUST INSPECT AND SURVEY THE SPACE BEFORE PERFORMING THE WORK.
- 3. THESE DRAWINGS ARE SCHEMATIC IN NATURE AND REPRESENT A COMPLETED PROJECT. MINOR MODIFICATIONS OF WORK SHALL BE PROVIDED BY THE CONTRACTOR TO COMPLY WITH PROJECT REQUIREMENTS, LOCATIONS OF DEVICES AND EQUIPMENT SHOW A GENERAL ARRANGEMENT AND INTENDED FUNCTION. ALL COMPONENTS SHOWN ON THE RISER DIAGRAMS, BUT NOT ON THE PLAN OR VICE VERSA, SHALL BE INCLUDED AS IF SHOWN ON BOTH. EXACT LOCATION OF MECHANICAL EQUIPMENT THAT REQUIRE ELECTRICAL CONNECTIONS ARE SHOWN ON THE MECHANICAL DRAWINGS. BEFORE INSTALLATION OF WORK, CHECK FOR SWINGS AND ALL REQUIRED CLEARANCES, TO AVOID INTERFERENCE WITH OTHER TRADES. COORDINATE WITH ALL CONTRACT DOCUMENTS, SHOP DRAWINGS AND EQUIPMENT DRAWINGS. THE CONTRACTOR IS RESPONSIBLE FOR OBTAINING ALL REQUIRED CONTRACT DRAWINGS.

GENERAL ABBREVIATIONS	A ADA AFF AFG AHJ AIC AL ATS AWG AXL  BFG BLDG  C CB CKT CL CLF CT CU DWG	AMPERES AMERICANS WITH DISABILITIES ACT ABOVE FINISH FLOOR ABOVE FINISH GRADE AUTHORITY HAVING JURISDICTION AMPERE INTERRUPTING CAPACITY ALUMINUM AUTOMATIC TRANSFER SWITCH AMERICAN WIRE GAUGE ACROSS-THE-LINE MOTOR STARTER  BELOW FINISH GRADE BUILDING  CONDUIT CIRCUIT BREAKER CIRCUIT CENTERLINE CURRENT LIMITING FUSE CURRENT TRANSFORMER COPPER  DRAWING	LTG LFMC  MC MCB MCP MFR MLO  NC NEC NEMA NF NTS  P PH PVC  QTY  REQ'D RMC RTU	LIGHTING LIQUID-TIGHT FMC  METAL CLAD CABLE MAIN CIRCUIT BREAKER MOTOR CIRCUIT PROTECTOR MANUFACTURER MAIN LUGS ONLY  NORMALLY CLOSED NATIONAL ELECTRIC CODE NAT'L ELECTRICAL MFR'S ASSOC. NON FUSED NOT TO SCALE  POLE PHASE POLYVINYL CHLORIDE  QUANTITY  REQUIRED RIGID METAL CONDUIT ROOF TOP UNIT
	EC ECB EF EM EMT	ELECTRICAL CONTRACTOR ENCLOSED CIRCUIT BREAKER EXHAUST FAN EMERGENCY ELECTRICAL METALLIC TUBING	SP TYP	SPARE TYPICAL
	F FLA FMC	FUSE FULL LOAD AMPERES FLEXIBLE METAL CONDUIT	UG UON,UNO V	UNDERGROUND OR UNDERGRADE UNLESS OTHERWISE NOTED
	FT GFCI,GFI	FEET  GROUND-FAULT CIRCUIT INTERRUPTER	W WAP	WIRE WIRELESS ACCESS POINT
	GND,G	GROUND OR GROUNDING	WP	WEATHER PROOF RATED DEVICE
	HOA	HAND, OFF, AUTOMATIC SWITCH	xfmr D	TRANSFORMER DELTA
	KCMIL KVA KW	THOUSAND CIRCULAR MILS KILOVOLT AMPERES KILOWATTS	Υ Φ	WYE PHASE

## DRAWING NOTATION

HEAVY & SOLID INDICATES LIGHTING FIXTURES TO BE REMOVED AND REPLACED IN KIND BY CONTRACTOR.

TEXT ADJACENT TO EQUIPMENT IS SOMETIMES ADDED FOR EXTRA CLARIFICATION ON DEMO/EXISTING TO REMAIN ITEMS. REFER TO LIST BELOW FOR DEFINITIONS.

TBR EXISTING EQUIPMENT TO BE REMOVED BY CONTRACTOR

ETR existing equipment to remain. Contractor shall MAINTAIN IN OPERATION.


EXISTING EQUIPMENT TO BE REMOVED AND RELOCATED AS ERE SHOWN BY CONTRACTOR.

> EXISTING EQUIPMENT TO BE REMOVED AND REPLACED WITH NEW BY CONTRACTOR

## LIGHT FIXTURES

'A' UPPER CASE LETTER INDICATES FIXTURE TYPE.

- LOWER CASE LETTER INDICATES SWITCH CONTROL. WHERE NO SWITCH CONTROL DESIGNATION IS PROVIDED, CONTROL SHALL BE VIA MASTER ROOM SWITCH OR MASTER ROOM OCCUPANCY SENSOR (WHERE
- '#' INDICATES PANELBOARD CIRCUIT TO WHICH FIXTURE SHALL BE CIRCUITED.
- 'NL' INDICATES NIGHT LIGHT. FIXTURE SHALL NOT HAVE SWITCH CONTROL.

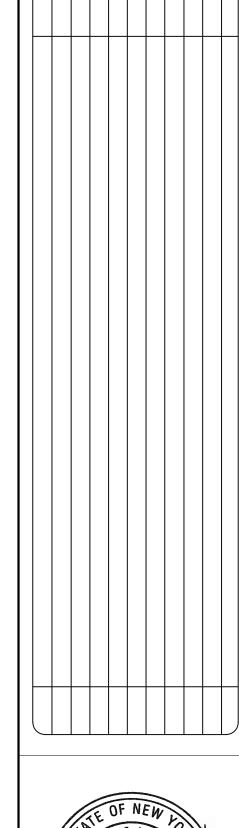







ELECTRICAL LEGENDS, ABBREVIATIONS, & GENERAL NOTES

JSE SHEET NO. **E001** 

REVIEW DOCUMENTS

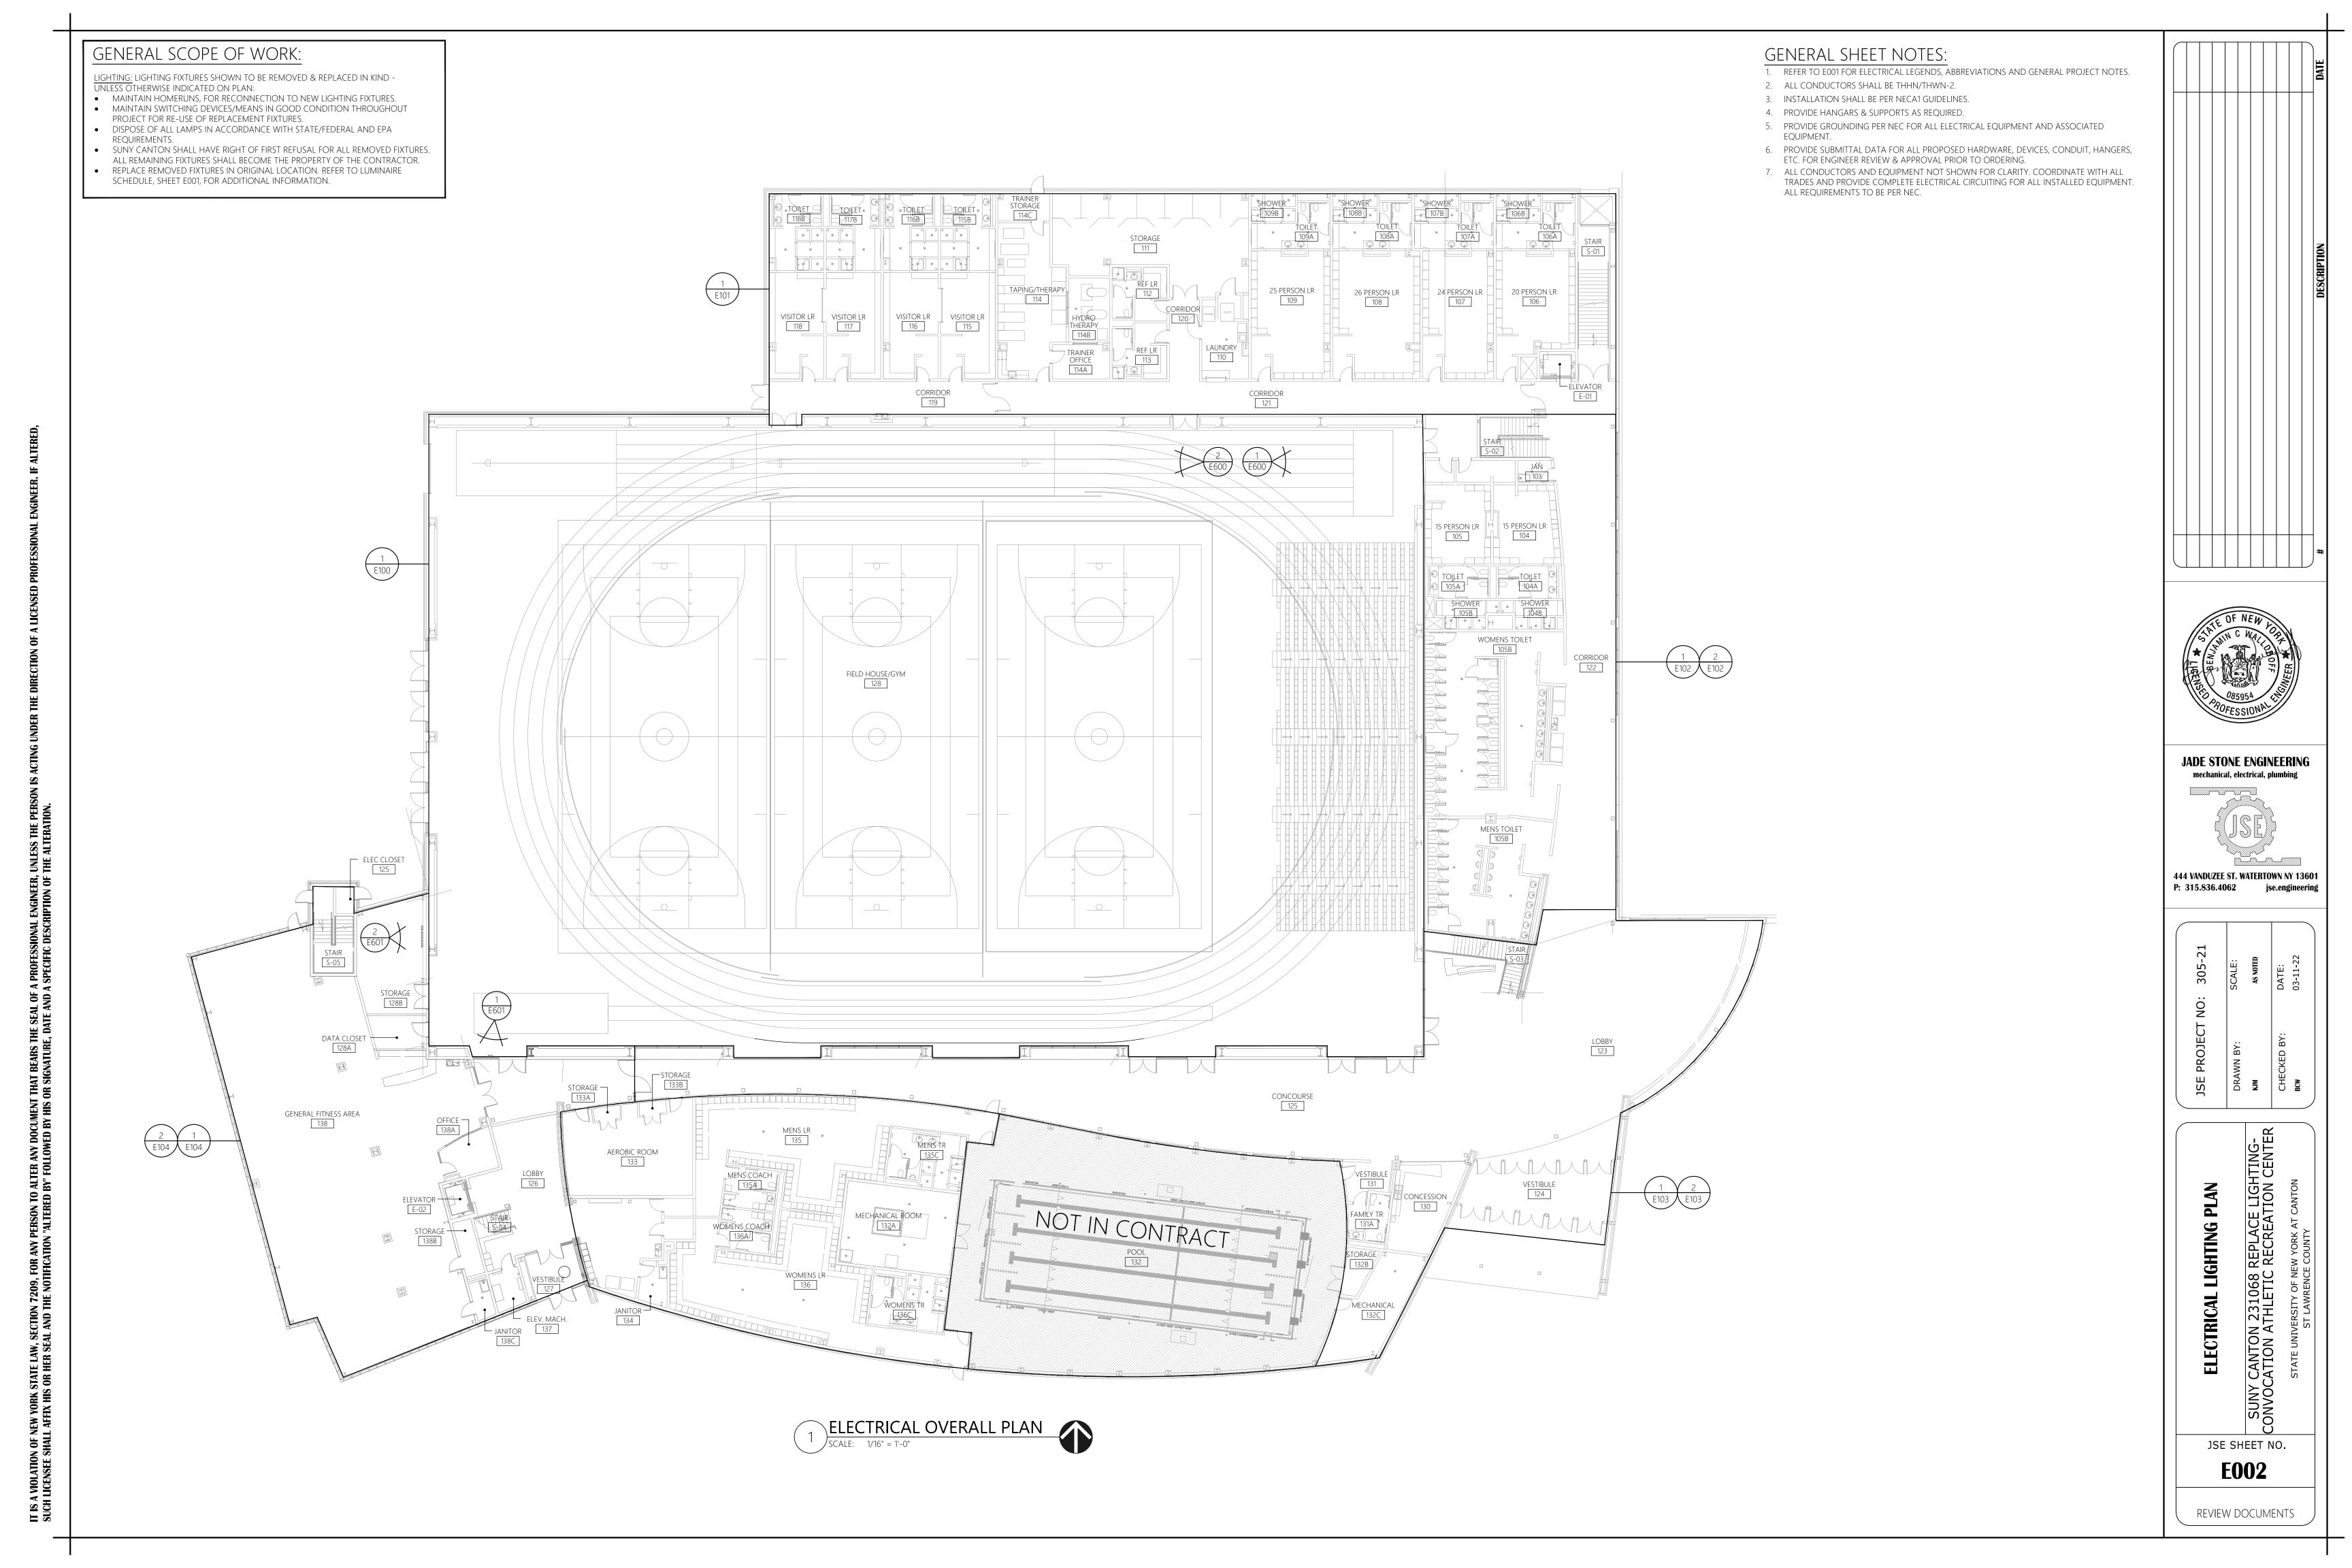

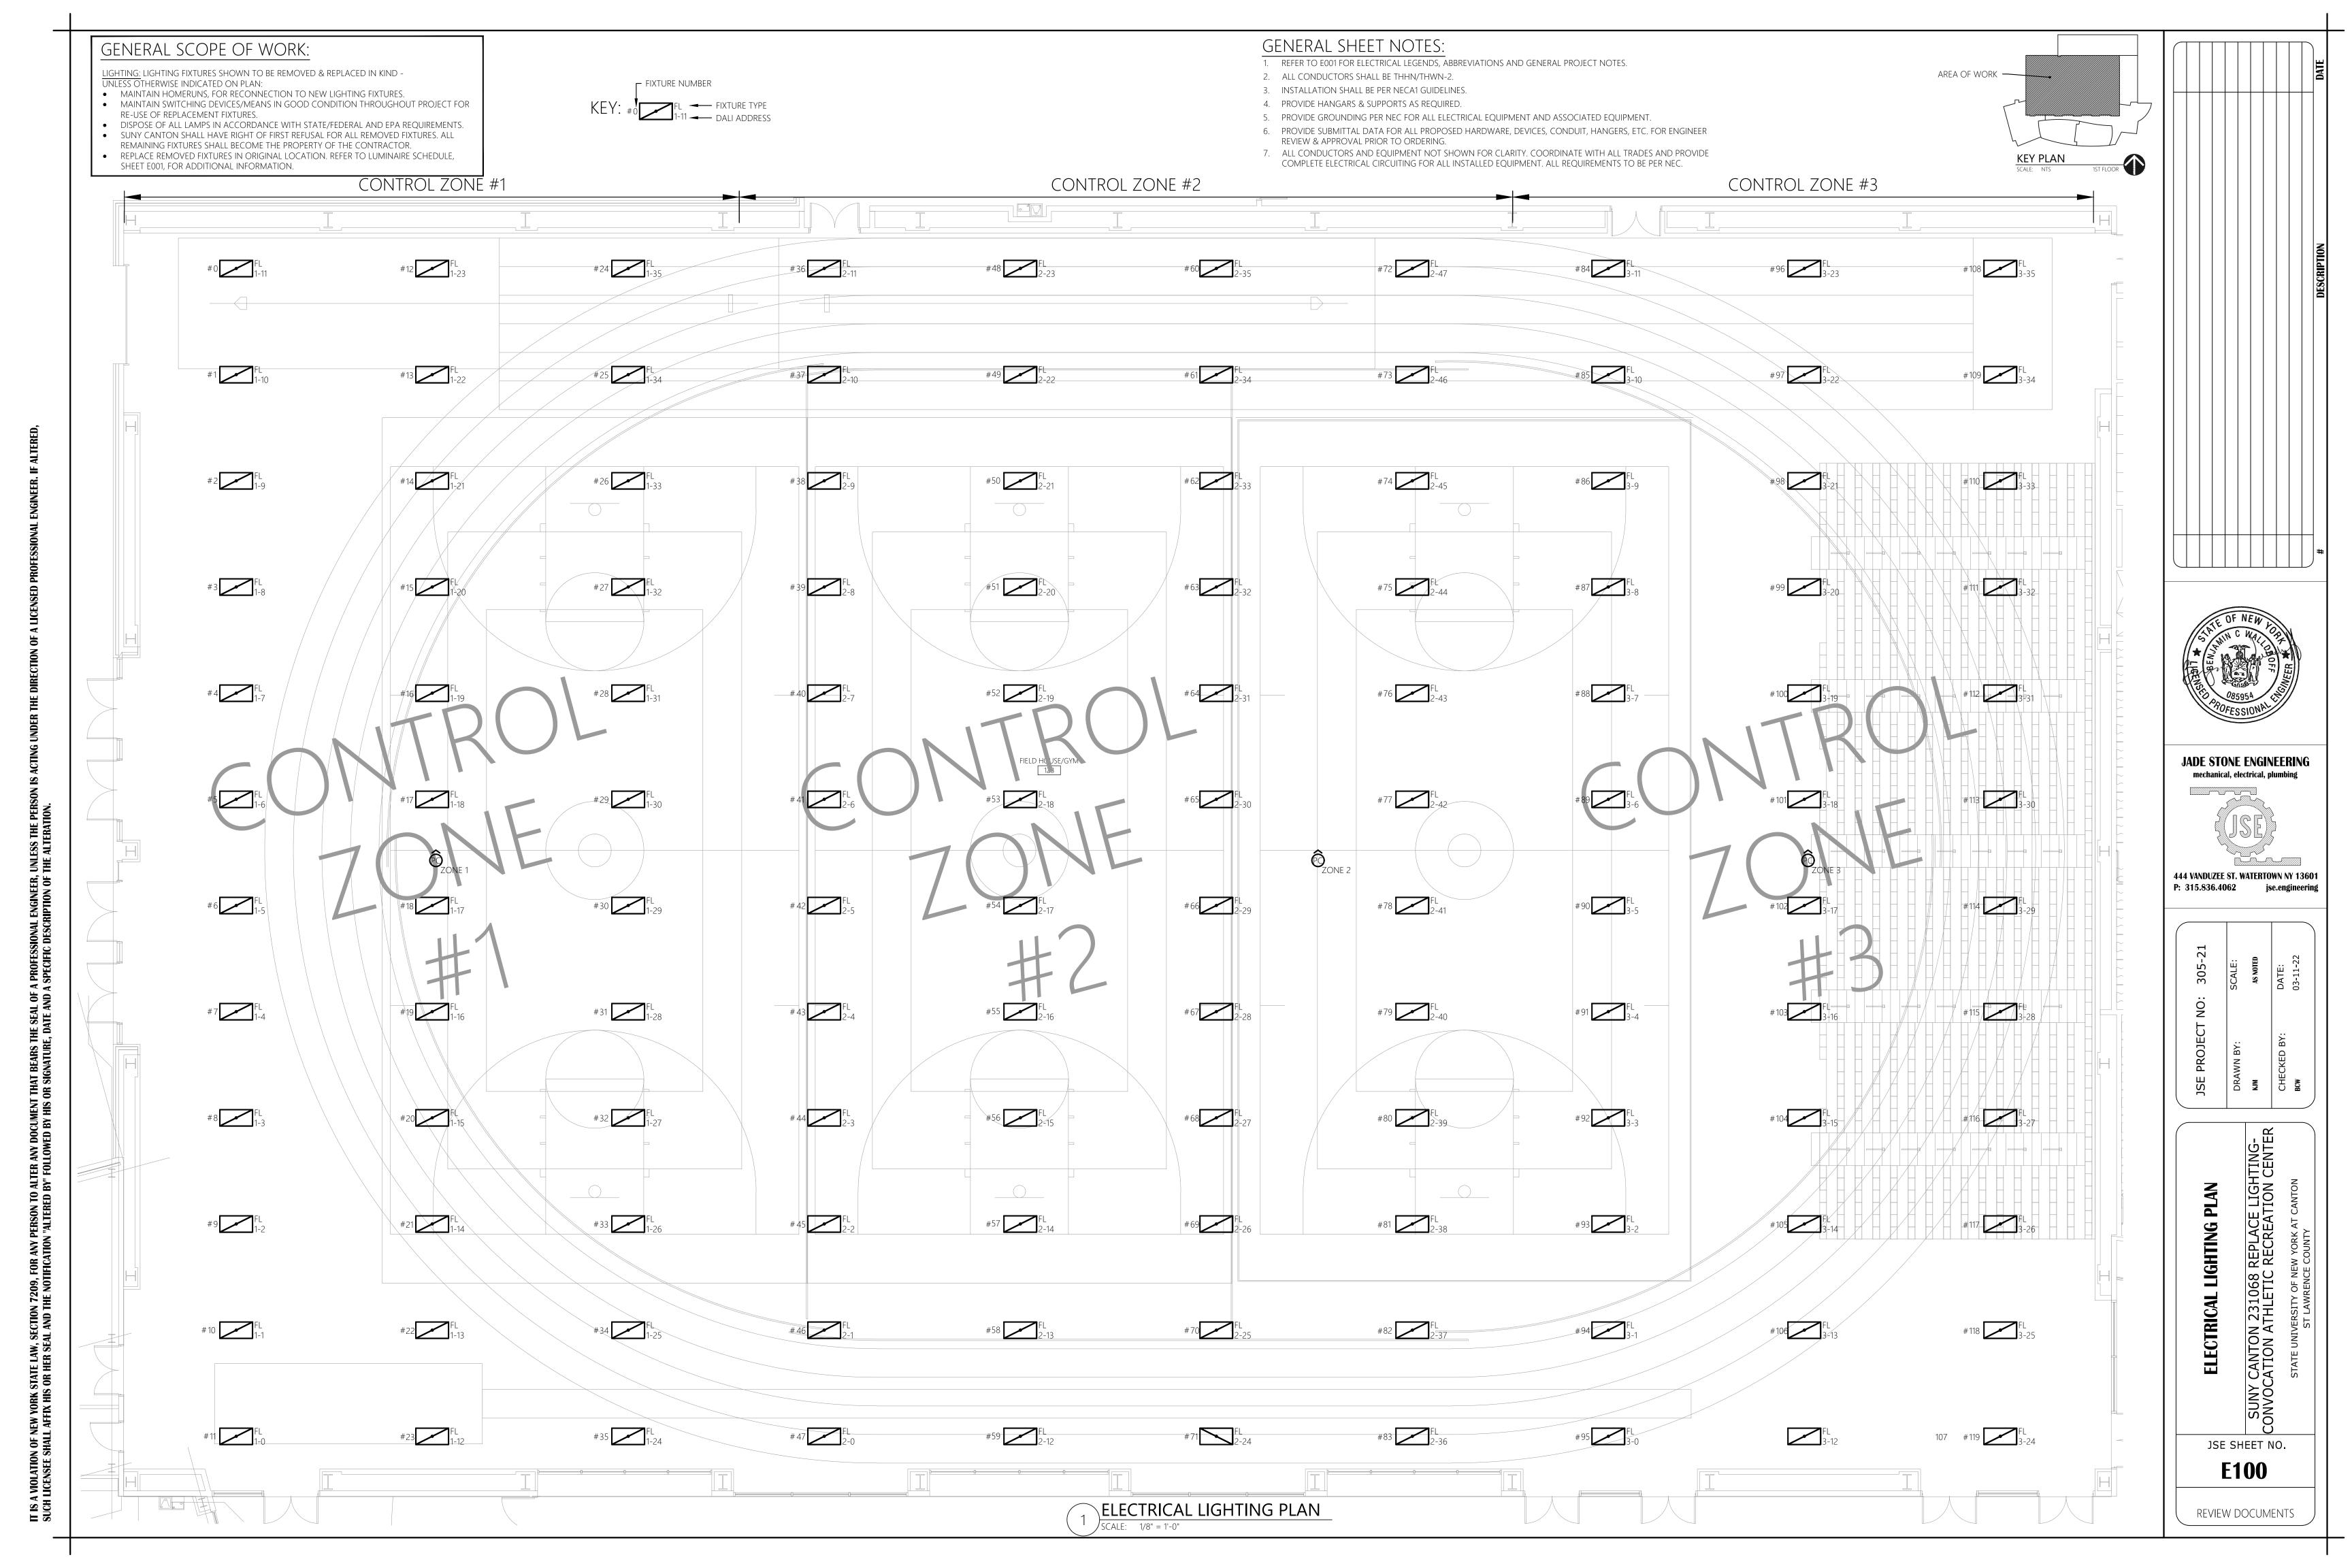

IT IS A VIOLATION OF NEW YORK STATE LAW, SECTION 7209, FOR ANY PERSON TO ALTER ANY DOCUMENT THAT BEARS THE SEAL OF A PROFESSIONAL ENGINEER, UNLESS THE P SUCH LICENSEE SHALL AFFIX HIS OR HER SEAL AND THE NOTIFICATION "ALTERED BY" FOLLOWED BY HIS OR SIGNATURE, DATE AND A SPECIFIC DESCRIPTION OF THE ALTERATION

GENERAL SCOPE OF WORK:

<u>LIGHTING:</u> LIGHTING FIXTURES SHOWN TO BE REMOVED & REPLACED IN KIND - UNLESS OTHERWISE INDICATED ON PLAN:

• MAINTAIN HOMERUNS, FOR RECONNECTION TO NEW LIGHTING FIXTURES. MAINTAIN SWITCHING DEVICES/MEANS IN GOOD CONDITION THROUGHOUT PROJECT FOR

RE-USE OF REPLACEMENT FIXTURES.

• DISPOSE OF ALL LAMPS IN ACCORDANCE WITH STATE/FEDERAL AND EPA REQUIREMENTS. SUNY CANTON SHALL HAVE RIGHT OF FIRST REFUSAL FOR ALL REMOVED FIXTURES. ALL

REMAINING FIXTURES SHALL BECOME THE PROPERTY OF THE CONTRACTOR.

 REPLACE REMOVED FIXTURES IN ORIGINAL LOCATION. REFER TO LUMINAIRE SCHEDULE, SHEET E001, FOR ADDITIONAL INFORMATION.


## GENERAL SHEET NOTES:

1. REFER TO E001 FOR ELECTRICAL LEGENDS, ABBREVIATIONS AND GENERAL PROJECT NOTES.

5. PROVIDE GROUNDING PER NEC FOR ALL ELECTRICAL EQUIPMENT AND ASSOCIATED

ETC. FOR ENGINEER REVIEW & APPROVAL PRIOR TO ORDERING.

7. ALL CONDUCTORS AND EQUIPMENT NOT SHOWN FOR CLARITY. COORDINATE WITH ALL TRADES AND PROVIDE COMPLETE ELECTRICAL CIRCUITING FOR ALL INSTALLED EQUIPMENT.

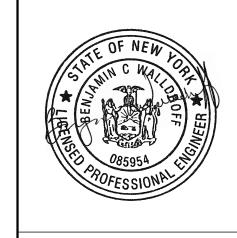



305-21 SCALE:

SUNY CANTON 231068 REPLACE LIGHTING-CONVOCATION ATHLETIC RECREATION CENTER


KEY PLAN


SCALE: NTS 1ST FLOOR


REVIEW DOCUMENTS

JSE SHEET NO.

E101

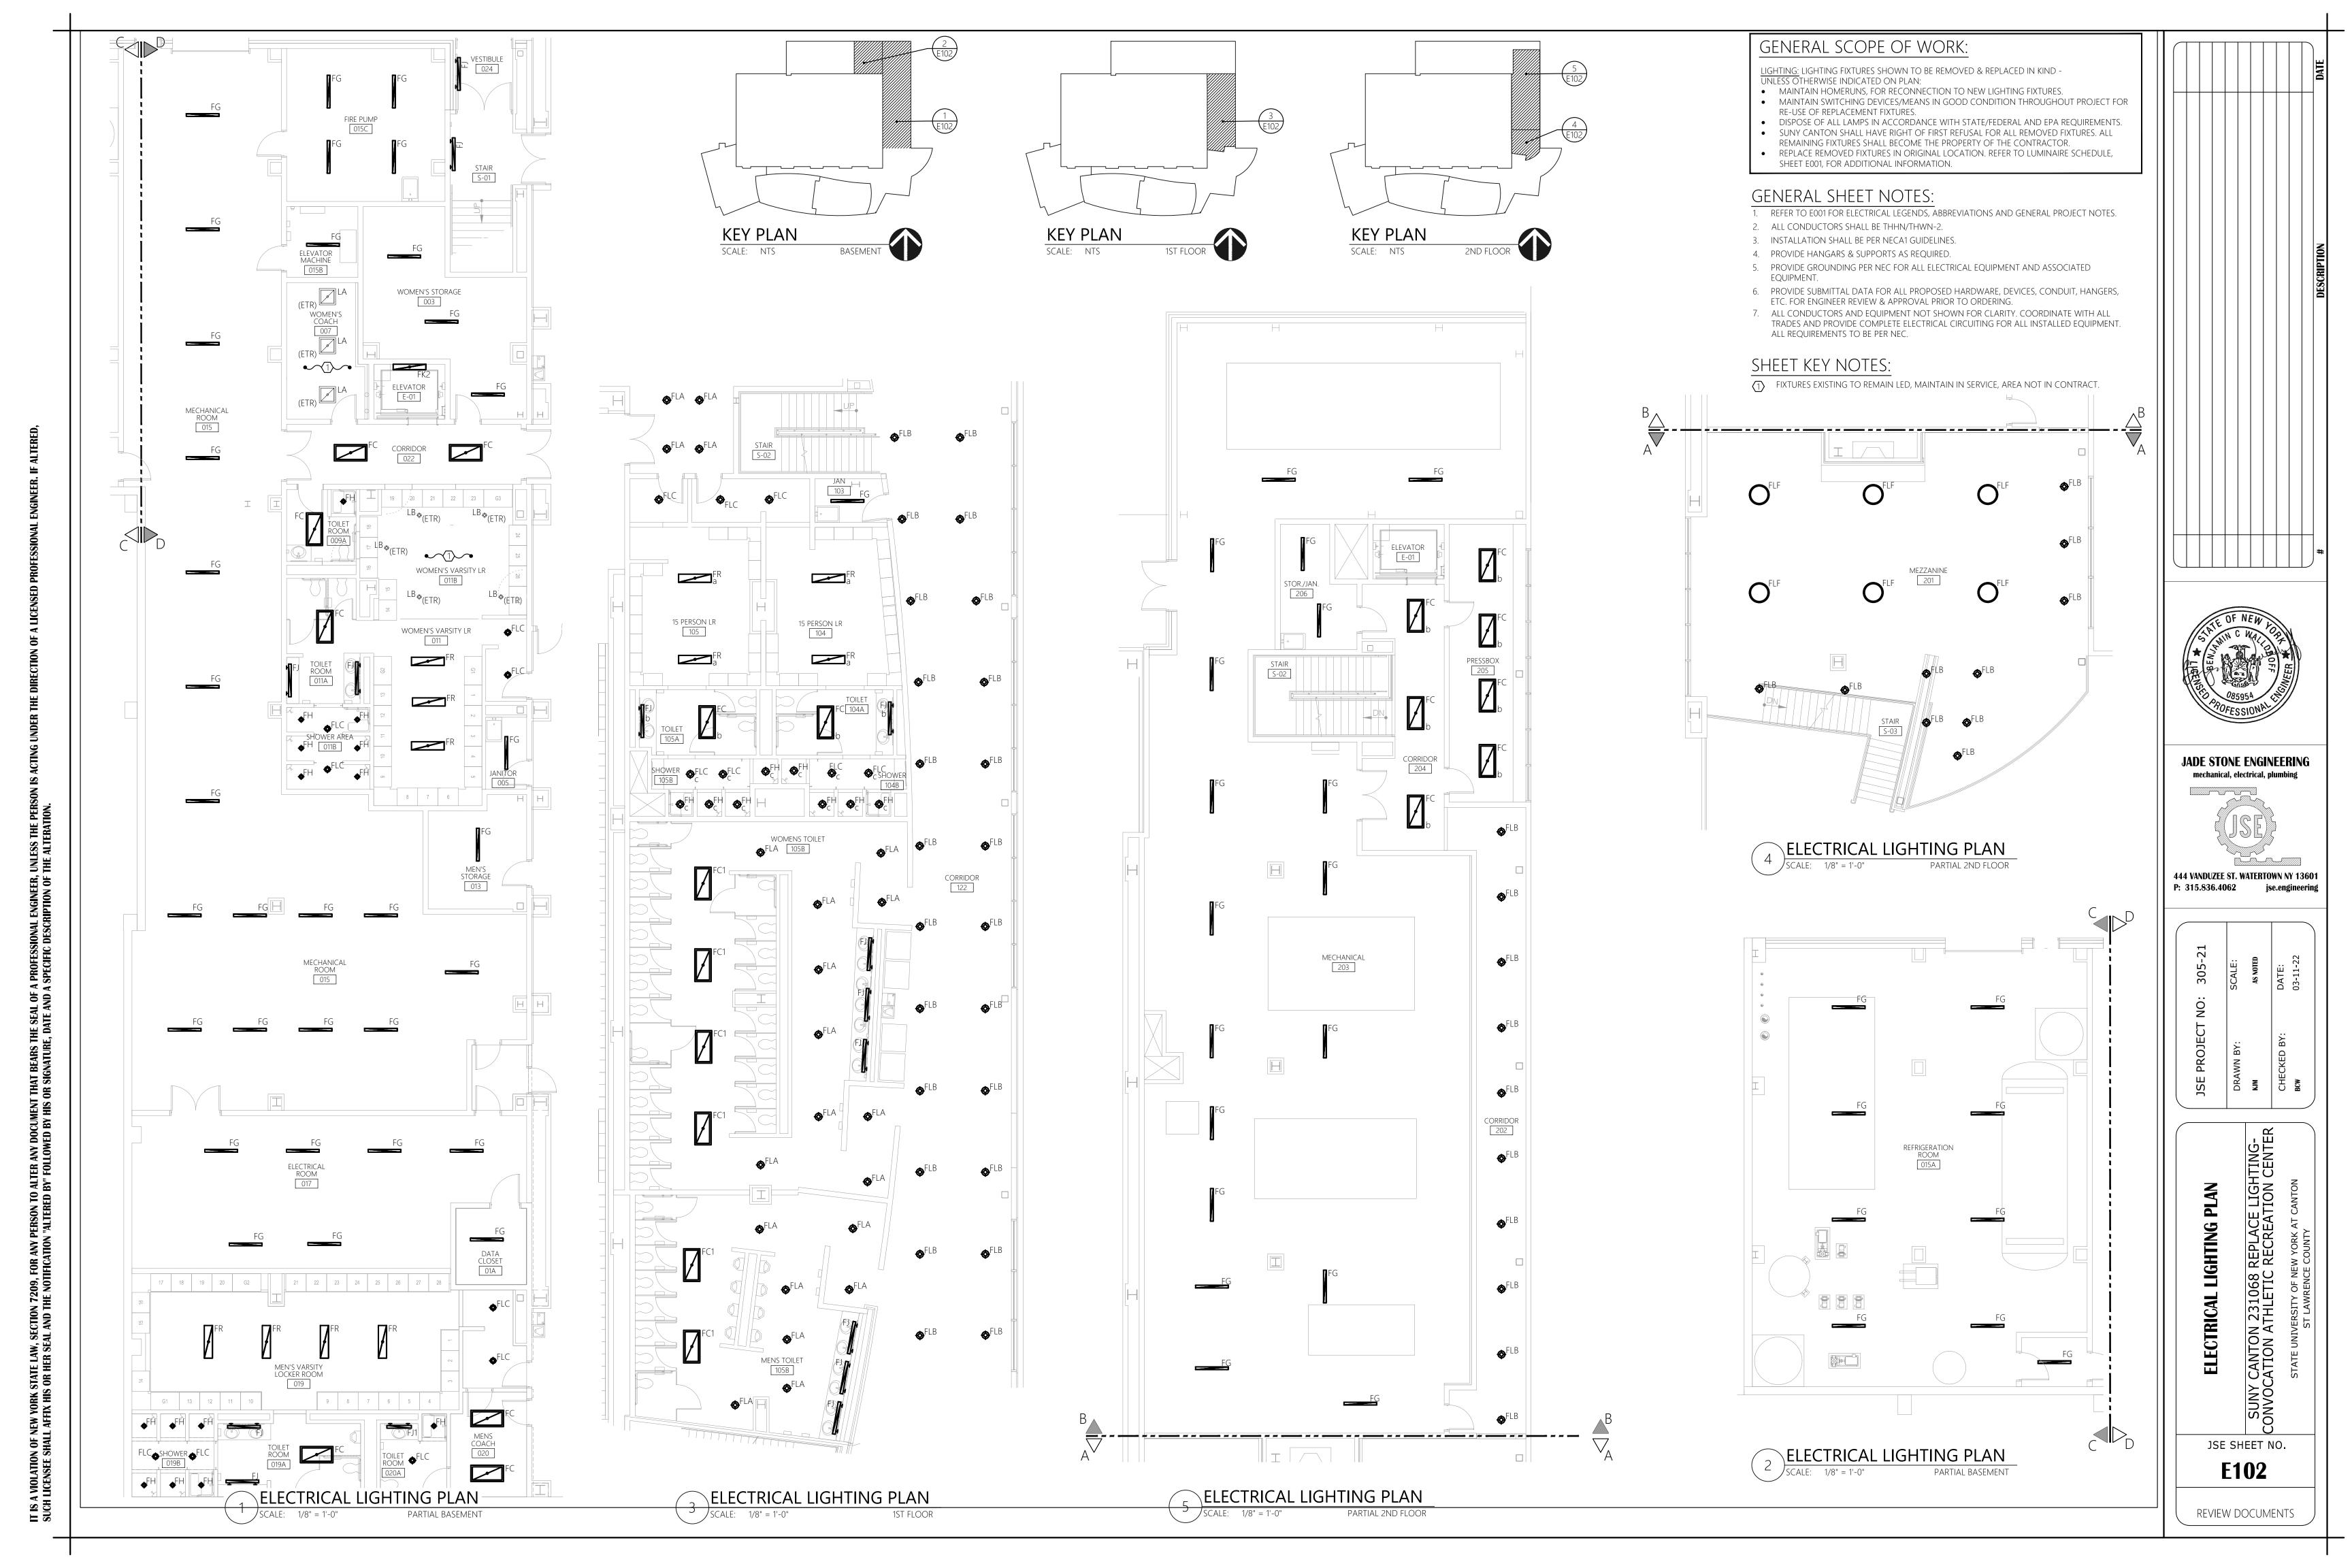

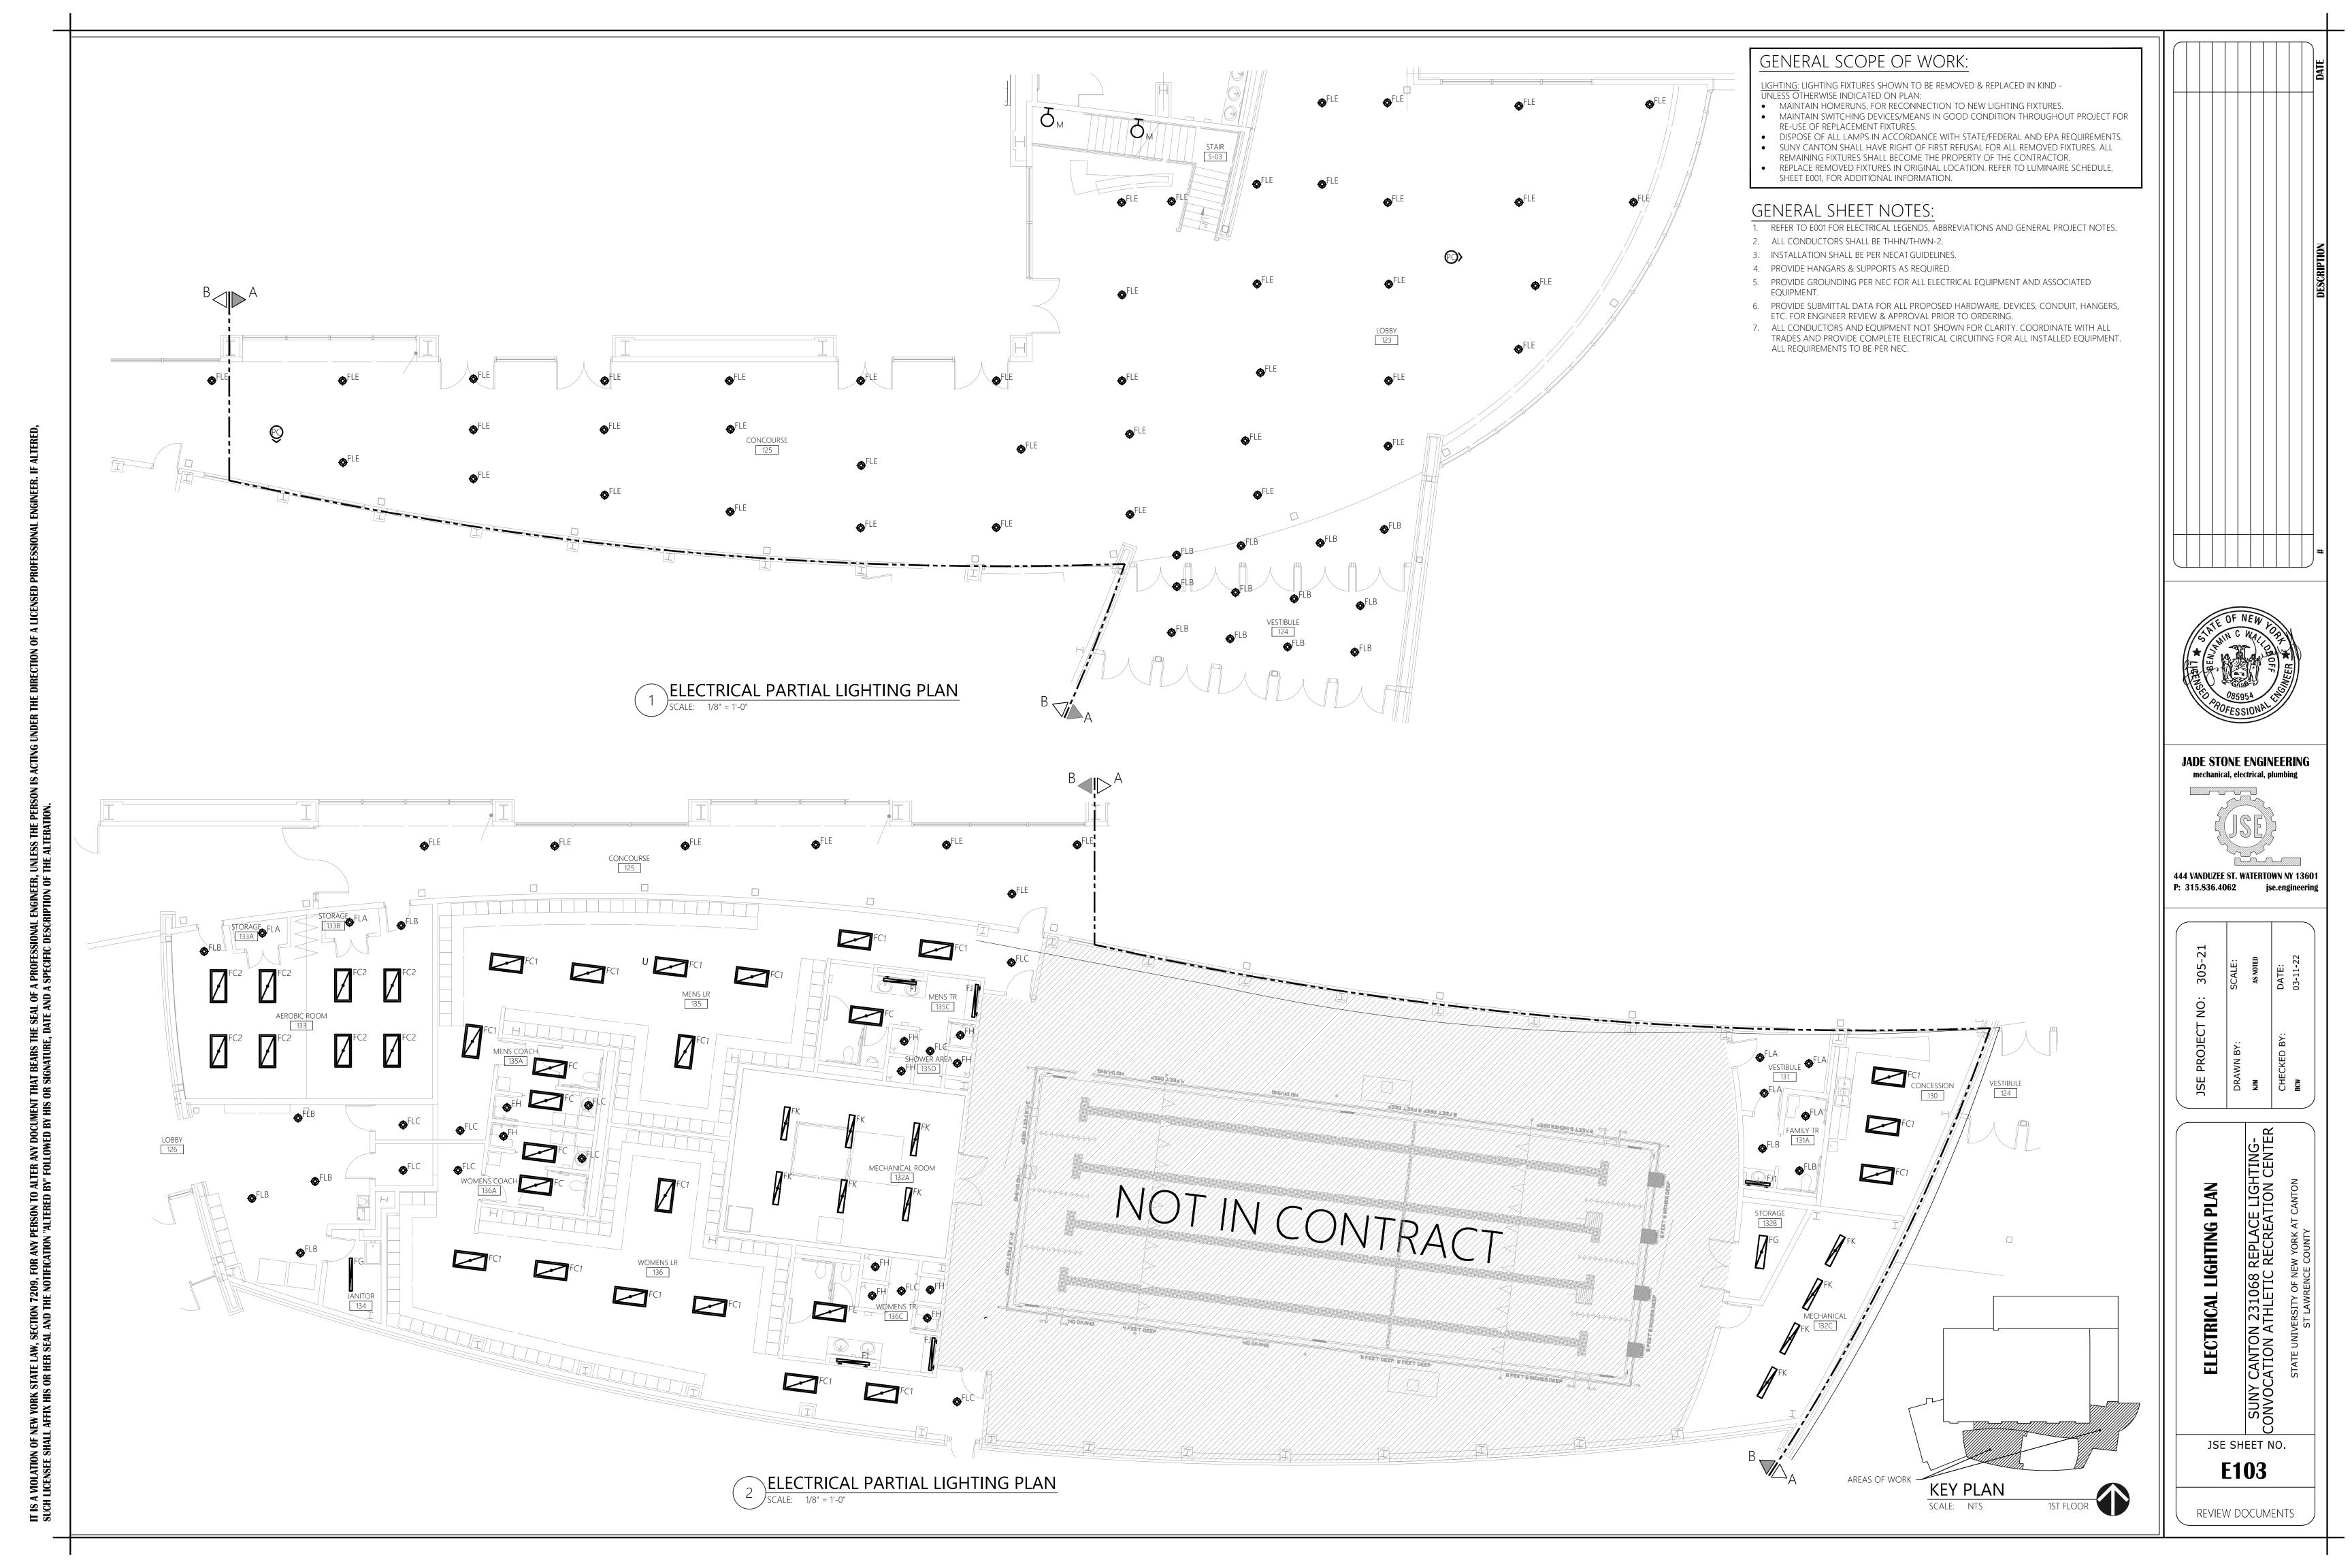

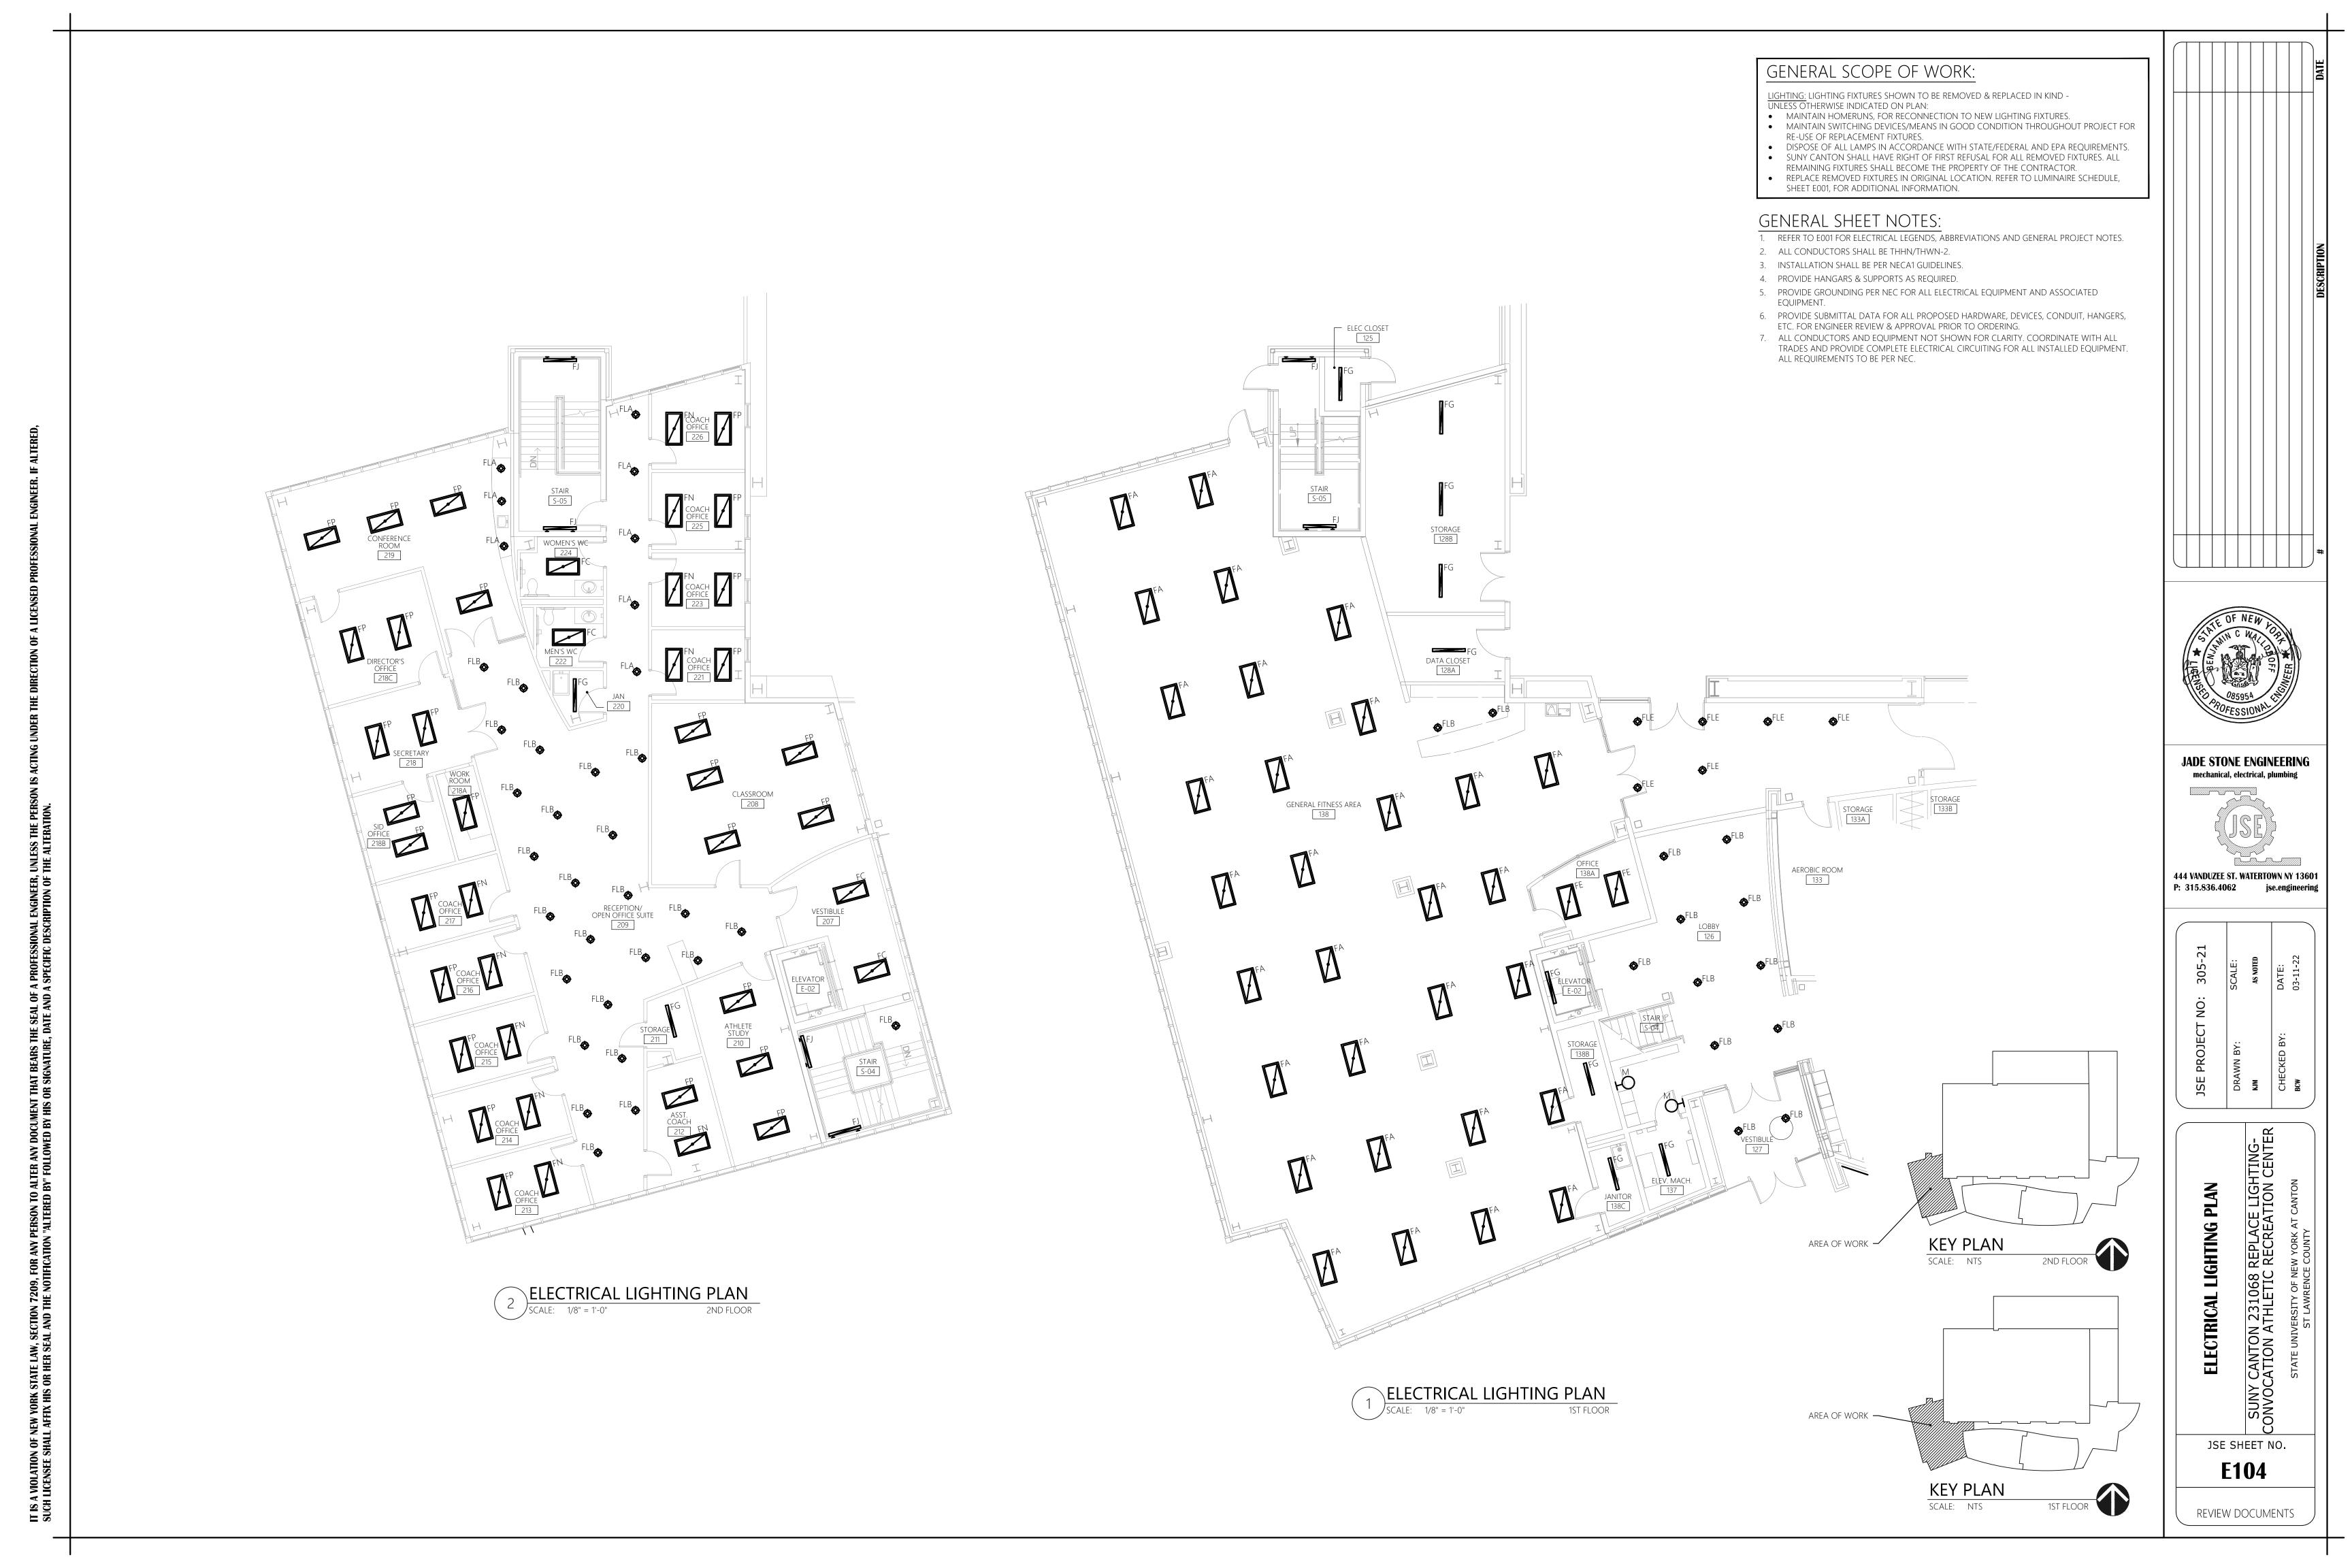

		LUMIN	IAIRE SCH	EDULE					
TYPE	DESCRIPTION	FIXTURE BASIS OF DESIGN	LENS/DIFFUSER	VOLTAGE	LAMPS	ENERGY	MOUNTING	DMMING	REMARKS
FA	2X4 RECESSED ARCHITECTURAL	metalux cruse st 24cz2-85vhe-unv-l840-cd1-u	FROSTED ACRYLIC	277V	57.9W, 4000K 8600L		RECESSED GRID	YES	
FB	2X4 RECESSED ARCHITECTURAL	METALUX CRUSE ST 24CZ2-65-UNV-L840-CD1-U	FROSTED ACRYLIC	277V	50.1W, 4000K 6601L		RECESSED GRID	YES	
FC	2X4 RECESSED ARCHITECTURAL	METALUX CRUSE ST 24CZ2-45-UNV-L840-CD1-U	FROSTED ACRYLIC	277V	35W, 4000K 4602L		RECESSED GRID	YES	
FC1	2X4 RECESSED ARCHITECTURAL WITH DRYWALL KIT	METALUX CRUSE ST 24CZ2-45-UNV-L840-CD1-U-DF-24W-U	FROSTED ACRYLIC	277V	35W, 4000K 4602L		RECESSED GRID	YES	
FE	2X4 RECESSED ARCHITECTURAL	METALUX PERCEIVE 24PD-55-PC3-L840-U	FROSTED ACRYLIC	277V	41.2W, 4000K 5451L	FIXTURE 'OR-EQUAL' EQUIVALENT MUST BE PRE-APPROVED BY THE ENGINEER TO ENSURE ENERGY PROFILES OF	RECESSED GRID	YES	
FF	2X4 RECESSED ARCHITECTURAL	METALUX PERCEIVE 24PD-45-PC3-L840-U	FROSTED ACRYLIC	277V	33W, 4000K 4330L		RECESSED GRID	YES	
FG	LENSED LED STRIP	METALUX 4SNLED-LD5-50SL-LW-UNV-L840-CD-1-U	FROSTED ACRYLIC	277V	46W, 4000K 5251L		SURFACE OR PENDANT	NO	
FH	LED 6" ROUND DOWNLIGHT RE-LAMP (1) 14.5W LED (4-PIN G24Q BASE)	GREEN CREATIVE MODEL#14.5PLH/840/DIR	POLYCARBONATE	277V	14.5W,4000K 1800L		RECESSED	YES	
FJ	4' LED ABOVE VANITY	TERON LIGHTING SURE SHOT SSD48-L49.0-ZE1500-120V-ZE-#-40K	WHITE ACRYLIC	277V	49W, 4000K 7161L		SURFACE WALL	NO	
FJ1	3' LED ABOVE VANITY	TERON LIGHTING SURE SHOT SSD36-L59.5-ZE1750-120V-#-40K	WHITE ACRYLIC	277V	59.5W, 4000K 8695L		SURFACE WALL	NO	
FK	4' LED NARROW VAPOR-TIGHT	ILP WTZ4-5L-U-40-RAFL	FROSTED ACRYLIC	277V	38W, 4000K 5201L		SURFACE CEILING	NO	
FK2	4' LED NARROW VAPOR-TIGHT	ILP WTZ4-9L-U-40-RAFL	FROSTED ACRYLIC	120	66W, 4000K 9358L		SURFACE CEILING	NO	
FL	2X4 LED HIGH BAY	METALUX OHBL-36SE-W-UNV-L840-5LTD-U/OHBL-WG164/Y-TOGGLE-10-2PK	-	277V	211W, 4000K 36,780L	NATIONAL GRID GOALS FOR THIS SPECIFIC PROJECT.	CHAIN HANG	NO	1 2 0
FN	2X4 RECESSED ARCHITECTURAL	METALUX CRUSE ST 24CZ2-80VHE-UNV-L840-CD1-U	FROSTED ACRYLIC	277V	53.8W, 4000K 8128L	PROJECT.	RECESSED GRID	YES	
FP	2X4 RECESSED ARCHITECTURAL	METALUX CRUSE ST 24CZ2-120VHE-UNV-L840-CD2-U	FROSTED ACRYLIC	277V	83.6W, 4000K 12,211L		RECESSED GRID	YES	
FLF	36" DIAMETER ROUND PENDANT	G-LIGHTING MERIDIAN GL-2343	WHITE ACRYLIC	277	99W, 4000K 9000L		Suspended	YES	
FLA	LED 6" ROUND DOWNLIGHT RETROFIT	HALO COMMERCIAL HC6R15D010-HM6R0525840-62RMDC	-	277V	14.5W, 4000K 1500L		RECESSED GRID	YES	
FLB	LED 6" ROUND DOWNLIGHT RETROFIT	HALO COMMERCIAL HC6R30D010-HM6R3040840-62RMDC	-	277V	28.6W, 4000K 3000L		RECESSED GYP	YES	
FLC	LED 8" ROUND DOWNLIGHT RE-LAMP (1) 14.5W LED (4-PIN G24Q BASE)	GREEN CREATIVE MODEL#14.5PLH/840/DIR	ETR	277V	14.5W, 4000K 1800L		RECESSED GRID	YES	
FLD	LED 8" ROUND DOWNLIGHT RE-LAMP (2) 14.5W LED (4-PIN G24Q BASE)	GREEN CREATIVE MODEL#14.5PLH/840/DIR	ETR	277V	(2) 14.5W, 4000K 3600L		RECESSED GYP	YES	
FLE	LED 10" ROUND DOWNLIGHT RETROFIT	ATLANTIC LIGHTING LED-RETRO-VR70-4K-2-DAL/10VR10MCL	-	277V	70W, 4000K 7000L		RECESSED GYP	YES	1 3
FR	1X4 LED SEALED FLAT PANEL	FAIL-SAFE FSP-14-42-40-CP187-DFV4/FSP-1248W-U	-	277V	38.3W, 4000K 4200L		SURFACE CEILING	YES	
▼ ▼ EBU	WALL-MOUNTED EMERGENCY LIGHTING FIXTURE	COOPER (SURE LITES) LEM	WHITE	120V	LED		WALL		
121	EXIT SIGN - QUANTITY & ORIENTATION OF FACES & HANDS AS INDICATED ON DRAWINGS	COOPER (EVENLITE) SOV-AC-R-1C/2M-WH-SW/RC	RED CLEAR 1 FACE MIRROR 2 FACE	120V	LED		CEILING OR WALL	N/A	

GENERAL SC	HEDULE	NOTES

- MODELS ARE GIVEN FOR QUALITY ONLY. SUBSTITUTE LIGHT FIXTURES SHALL BE OF APPROVED EQUAL OR GREATER QUALITY.
- PROVIDE ALL NECESSARY MOUNTING HARDWARE FOR CEILING TYPE PROPOSED.
- 3. CONTRACTOR SHALL PROVIDE LIGHTING FIXTURE SUBMITTALS FOR ALL FIXTURE TYPES PROPOSED FOR REVIEW AND APPROVAL.
- . WHERE THE PROPOSED FIXTURES DEVIATE FROM THE BASIS OF DESIGN, CONTRACTOR SHALL PROVIDE AGI LIGHTING CALCULATIONS FOR APPROVAL. (DESIGN TEAM TO PROVIDE BASE FILES FOR IMPORT PURPOSES)
- 5. LIGHTING FIXTURES SHALL BE PROVIDED WITH A 1-YEAR STANDARD WARRANTY UNLESS OTHERWISE NOTED HEREIN.

- 1) PROVIDE FIXTURE WITH 5-YEAR FULL WARRANTY, TO INCLUDE DRIVER.
- INSTALL FIELD HOUSE FIXTURES ON EXISTING HARDWARE/SUPPORTS. MINOR MODIFICATIONS TO EXISTING SUPPORTS SHALL BE ANTICIPATED. FIELD VERIFY EXISTING MOUNTING CONFIGURATION PRIOR TO BID.
- PROVIDE (1) 75W 0.1 SOLODRIVE DRIVER FOR EACH FIXTURE.
- PROVIDE (2) 5LTD DRIVERS FOR EACH FIXTURE.

G TWI LIGHTING CONTROL WATRIX										
DALI CONTROLLER #1				DALI CONTROLLER #2			DALI CONTROLLER #3			
FIXTURE #	CONTROLLER#	DALI ADDRESS#		FIXTURE #	CONTROLLER#	DALI ADDRESS#		FIXTURE #	CONTROLLER#	DALI ADDRESS#
# 1	1	- 0		# 37	2	- 0		# 85	3	- 0
# 2	1	- 1		# 38	2	- 1		# 86	3	- 1
# 3	1	- 2		# 39	2	- 2		# 87	3	- 2
# 4	1	- 3		# 40	2	- 3		# 88	3	- 3
# 5	1	- 4		# 41	2	- 4		# 89	3	- 4
# 6	1	- 5		# 42	2	- 5		# 90	3	- 5
# 7	1	- 6		# 43	2	- 6		# 91	3	- 6
# 8	1	- 7		# 44	2	- 7		# 92	3	- 7
# 9	1	- 8		# 45	2	- 8		# 93	3	- 8
# 10	1	- 9		# 46	2	- 9		# 94	3	- 9
# 11	1	- 10		# 47	2	- 10		# 95	3	- 10
# 12	1	- 11		# 48	2	- 11		# 96	3	- 11
# 13	1	- 12		# 49	2	- 12		# 97	3	- 12
# 14	1	- 13		# 50	2	- 13		# 98	3	- 13
# 15	1	- 14		# 51	2	- 14		# 99	3	- 14
# 16	1	- 15		# 52	2	- 15		# 100	3	- 15
# 17	1	- 16		# 53	2	- 16		# 101	3	- 16
# 18	1	- 17		# 54	2	- 17		# 102	3	- 17
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# 32		- 31		# 68		- 31		# 116	3	- 31
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# 35		- 34		# 71		- 34		# 119		- 34
# 36	1	- 35		# 72		- 35		# 120	3	- 35
				# 73	2	- 36				

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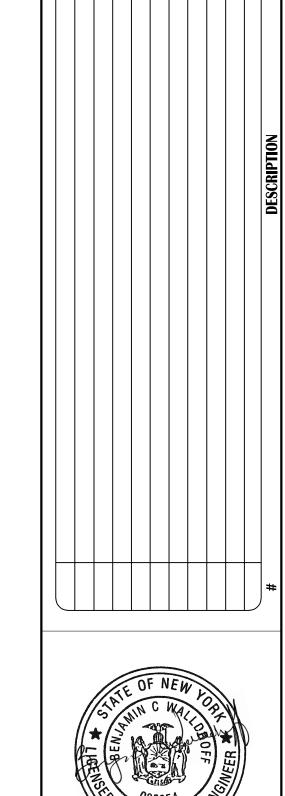
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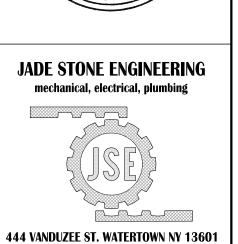
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# 83 2 - 46 # 84 2 - 47

GYM LIGHTING CONTROL MATRIX





P: 315.836.4062 jse.engineering

SUNY CANTON 231068 REPLACE LIGHTING-CONVOCATION ATHLETIC RECREATION CENTER

JSE SHEET NO.

**E500** 

review documents

REVIEW DOCUMENTS

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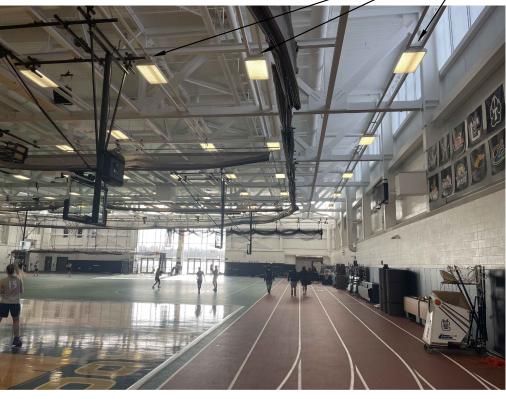
REPLACE EXISTING FIXTURES WITH NEW. MOUNT NEW FIXTURES IN SAME LOCATIONS. MAINTAIN EXISTING CONDUIT, CONDUCTORS & JUNCTION BOXES, TYP.

PHOTO OF EXISTING

FIELDHOUSE LIGHT FIXTURE

PHOTO OF EXISTING FIELDHOUSE LIGHT FIXTURE

REPLACE EXISTING FIXTURES WITH NEW. MOUNT NEW FIXTURES IN SAME LOCATIONS. MAINTAIN EXISTING CONDUIT, CONDUCTORS & JUNCTION BOXES, TYP.




- 1. REFER TO E001 FOR ELECTRICAL LEGENDS, ABBREVIATIONS AND GENERAL PROJECT NOTES.
- 2. ALL CONDUCTORS SHALL BE THHN/THWN-2.

GENERAL SHEET NOTES:

- 3. INSTALLATION SHALL BE PER NECA1 GUIDELINES.
- 4. PROVIDE HANGARS & SUPPORTS AS REQUIRED. 5. PROVIDE GROUNDING PER NEC FOR ALL ELECTRICAL EQUIPMENT AND ASSOCIATED EQUIPMENT.
- 6. PROVIDE SUBMITTAL DATA FOR ALL PROPOSED HARDWARE, DEVICES, CONDUIT, HANGERS, ETC.

FOR ENGINEER REVIEW & APPROVAL PRIOR TO ORDERING. 7. ALL CONDUCTORS AND EQUIPMENT NOT SHOWN FOR CLARITY. COORDINATE WITH ALL TRADES AND PROVIDE COMPLETE ELECTRICAL CIRCUITING FOR ALL INSTALLED EQUIPMENT. ALL REQUIREMENTS TO BE PER NEC.

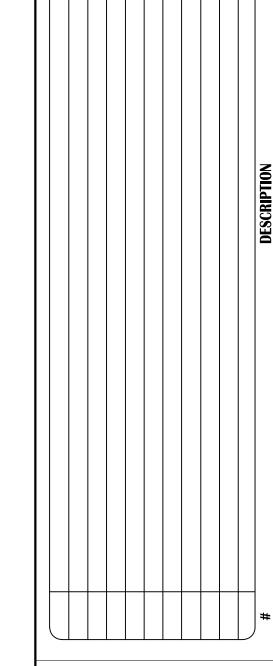







SUNY CANTON 231068 REPLACE LIGHTING-CONVOCATION ATHLETIC RECREATION CENTER

JSE SHEET NO.

**E600** 

REVIEW DOCUMENTS

